


PROPOSED GROUND FLOOR PLAN
SCALE 1:50

- NOTES: All detailed measurements are approximate.
- NOTES: All measurements of neighbouring properties are approximate including garden levels and will be subject to Party Wall Matters.
- NOTES: All recessed beams assume that the floor thickness is 6 inches. This cannot be confirmed until the opening up work during the build phase.
- NOTES: All proposed skylight sizes subject to final onsite measurements by chosen contractor.
- NOTES: Structural calculations and depth of all foundations for the new extension is to be confirmed by the building control officer on site taking soil type and nearby trees into account prior to pouring concrete and commencement on site.


REV.	DATE	NOTES	CLIENT TD	PROJECT ADDRESS ANTILL ROAD, N15	SCALE 1:50@A3	DRAWING NO. P- 1		
					DATE 29-01-2021			
			DRAWING TITLE PROPOSED GROUND FLOOR PLAN	<div>00.511.522.533.544.55</div> <div>Meters @ 1:50@ A3</div>				

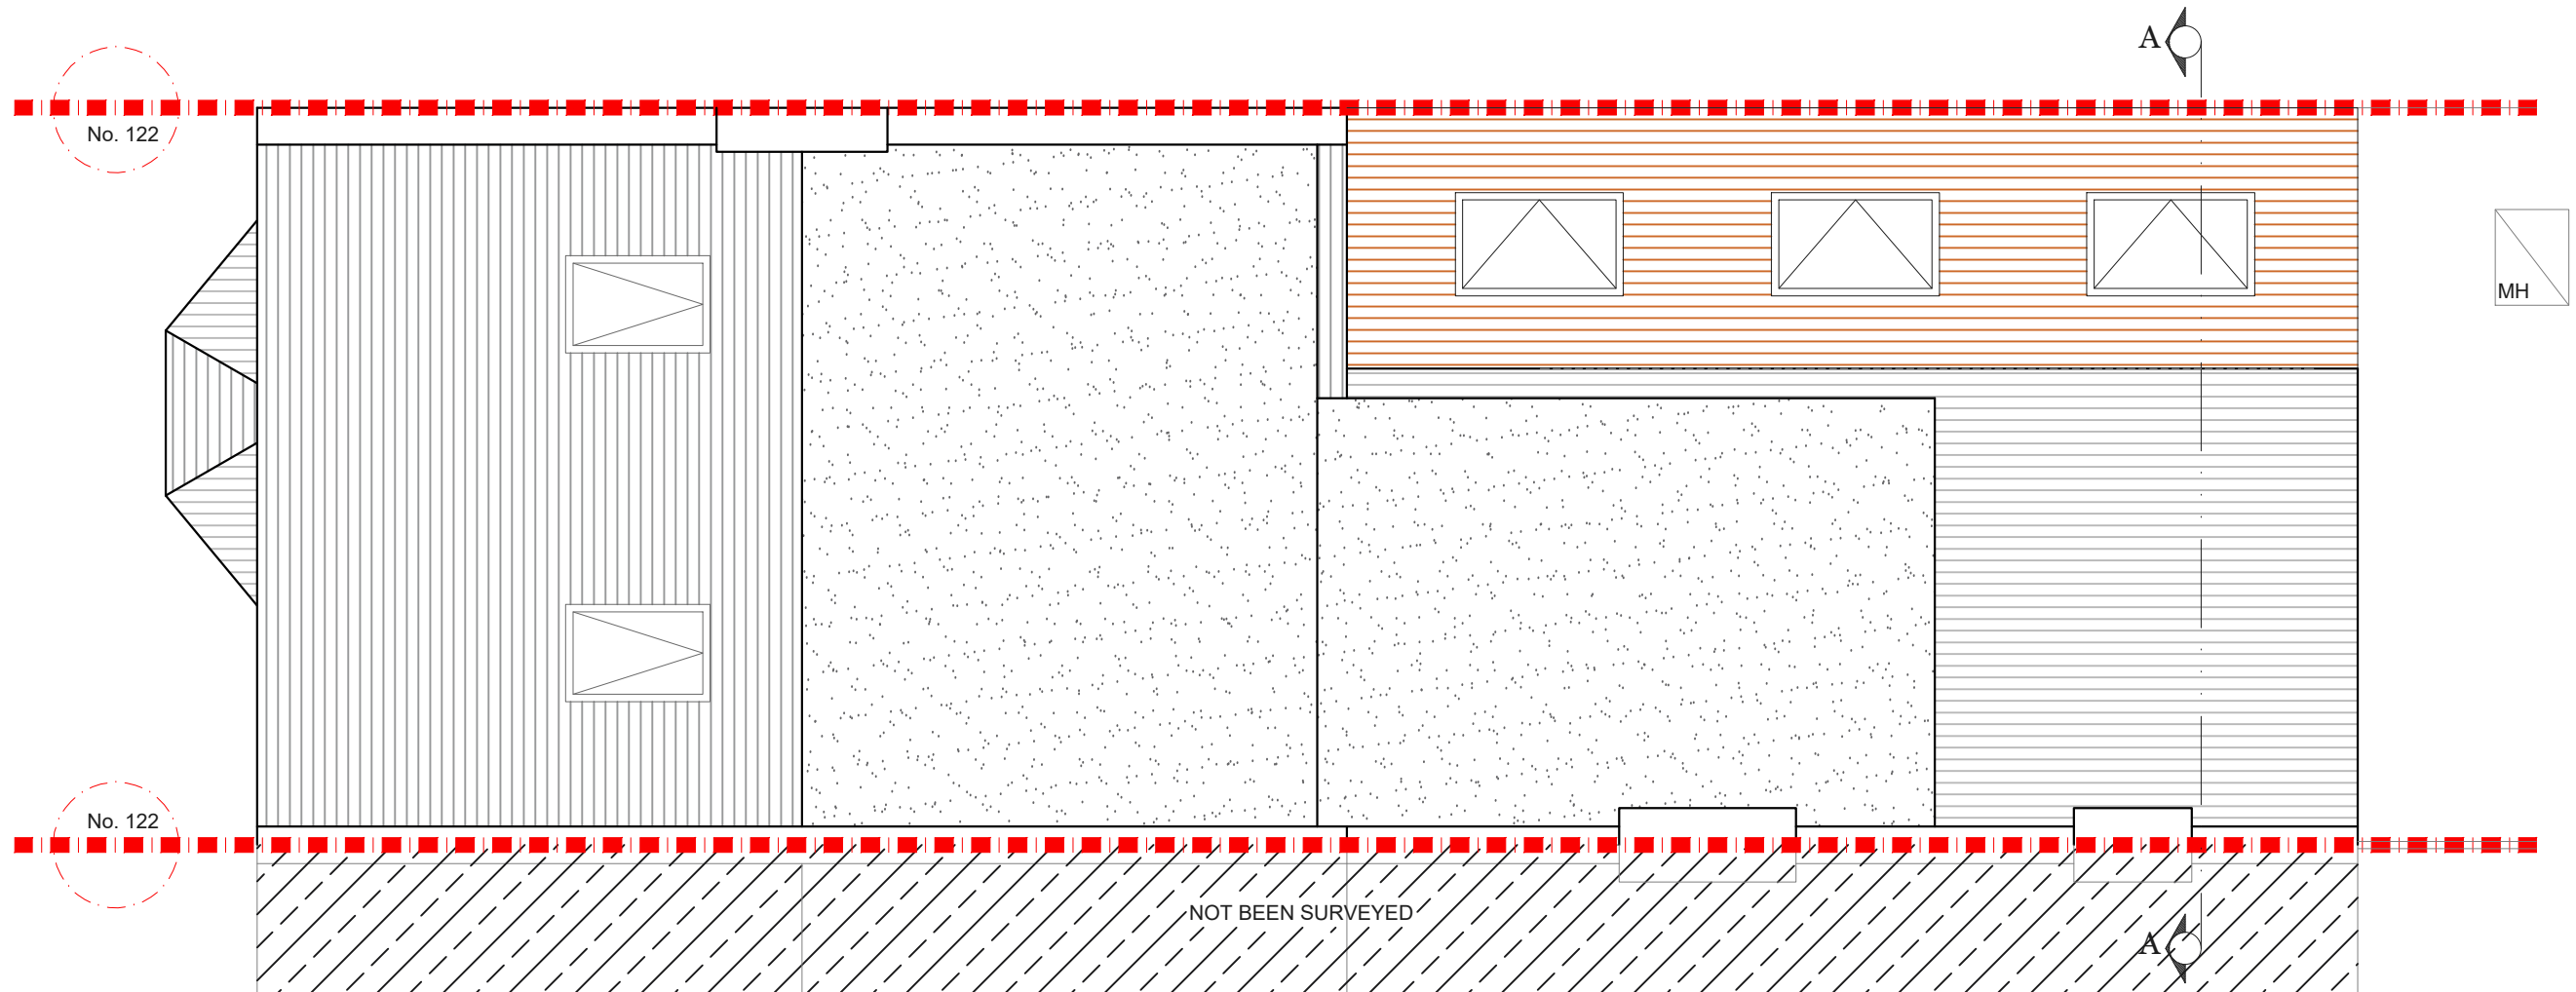

PROPOSED ROOF PLAN
SCALE 1:50

- NOTES:All detailed measurements are approximate.
- NOTES:All measurements of neighbouring properties are approximate including garden levels and will be subject to Party Wall Matters.
- NOTES: All recessed beams assume that the floor thickness is 6 inches. This cannot be confirmed until the opening up work during the build phase.
- NOTES: All proposed skylight sizes subject to final onsite measurements by chosen contractor.
- NOTES: Structural calculations and depth of all foundations for the new extension is to be confirmed by the building control officer on site taking soil type and nearby trees into account prior to pouring concrete and commencement on site.

REV.	DATE	NOTES	CLIENT TD	PROJECT ADDRESS ANTILL ROAD N15	SCALE 1:50@A3	DRAWING NO. P- 2			
					DATE 29-01-2021				
				DRAWING TITLE PROPOSED ROOF PLAN	<div>00.511.522.533.544.55</div> <div>Meters @ 1:50@ A3</div>				

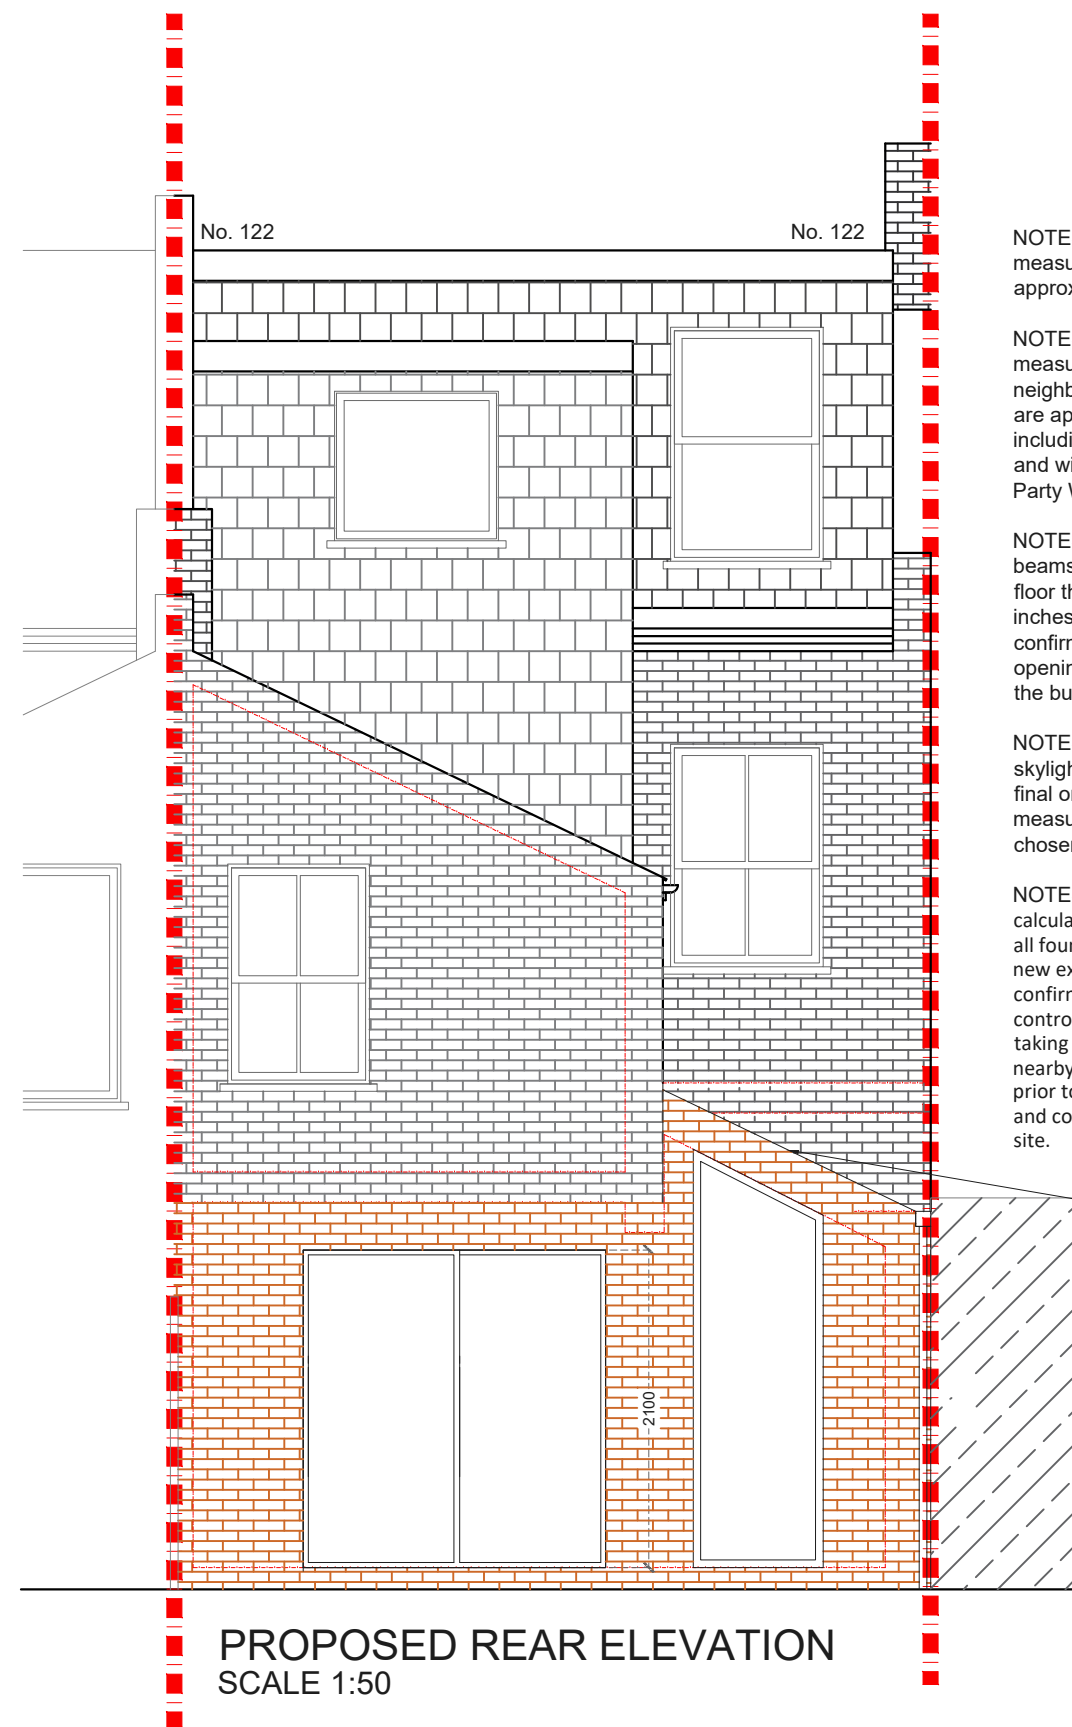

NOTES: All detailed measurements are approximate.


NOTES: All measurements of neighbouring properties are approximate including garden levels and will be subject to Party Wall Matters.

NOTES: All recessed beams assume that the floor thickness is 6 inches. This cannot be confirmed until the opening up work during the build phase.

NOTES: All proposed skylight sizes subject to final onsite measurements by chosen contractor.

NOTES: Structural calculations and depth of all foundations for the new extension is to be confirmed by the building control officer on site taking soil type and nearby trees into account prior to pouring concrete and commencement on site.

Contractor to make sure the angle of the extension roof to follow the outrigger roof angle.

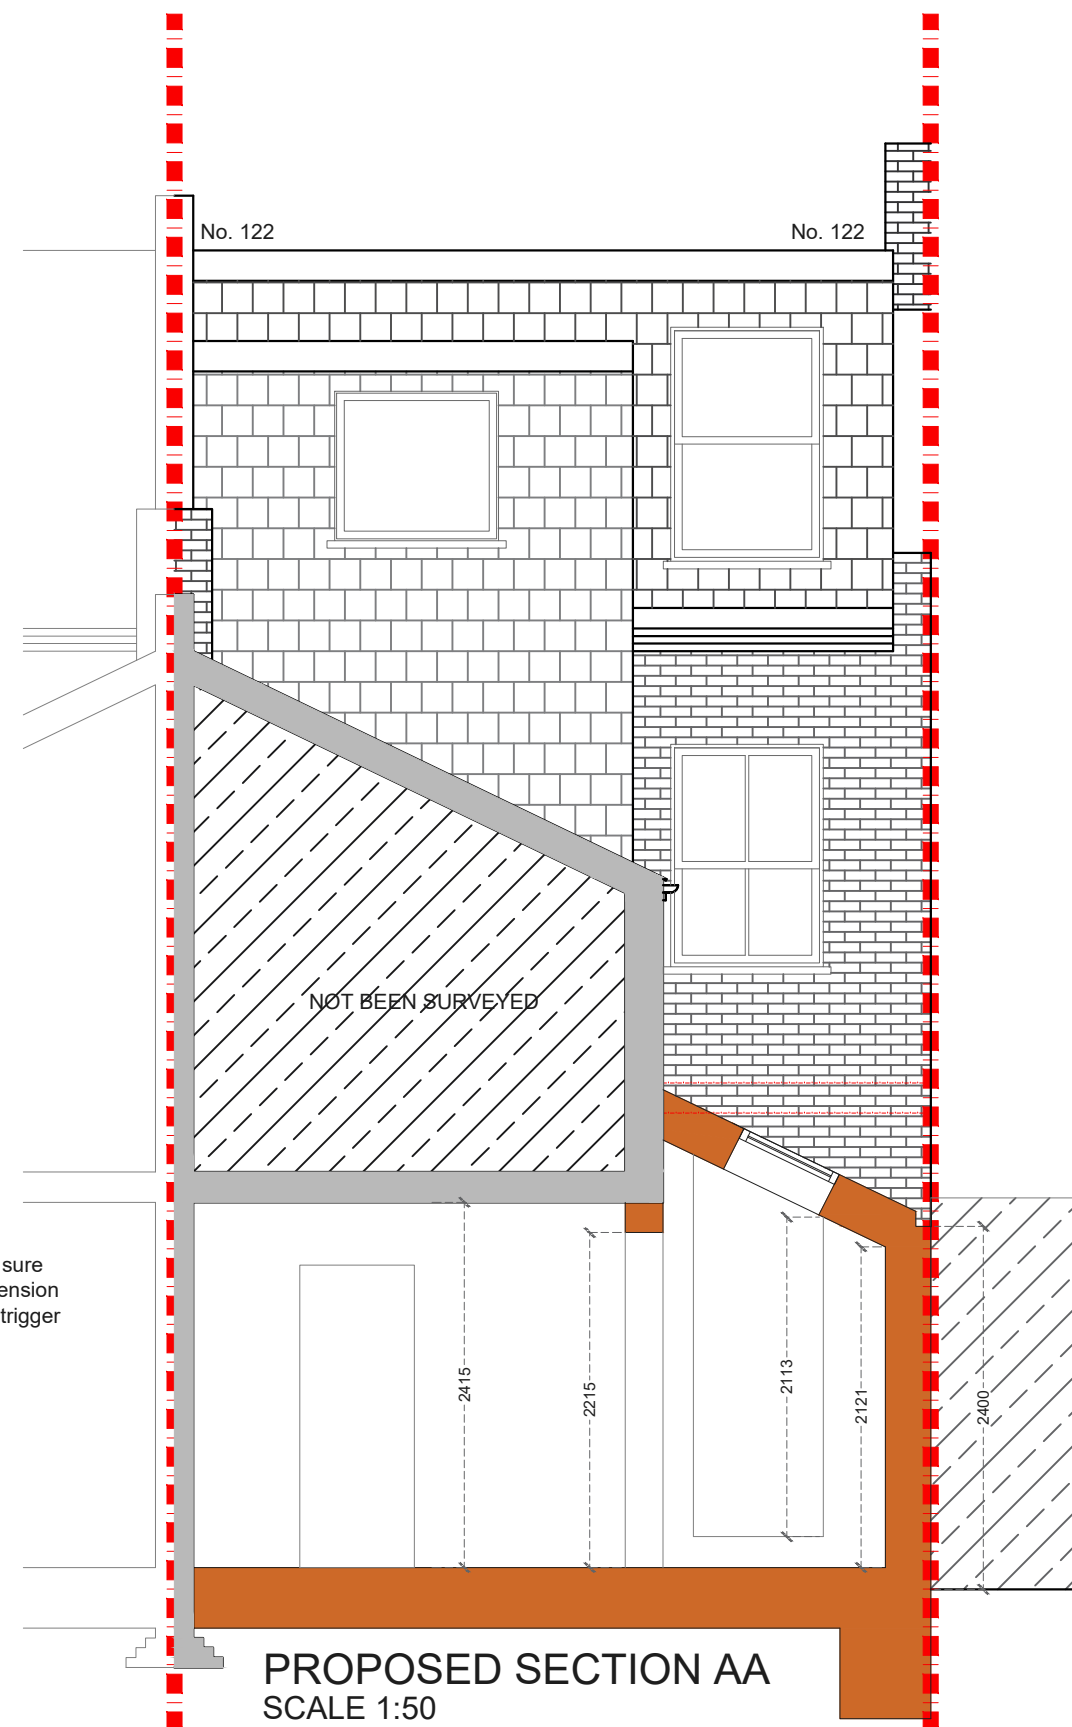

PROPOSED SECTION AA
SCALE 1:50

REV.	DATE	NOTES	CLIENT	PROJECT ADDRESS	SCALE	DRAWING NO.
			TD	ANTILL ROAD N15	1:50@A3	P- 3
					DATE	
					29-01-2021	
				DRAWING TITLE	<div>00.511.52.2533.54.4.55</div> <div>Meters @ 1:50@ A3</div>	
				PROPOSED REAR ELEVATION AND SECTION AA		