

| DRAWING TITLE |
|-----------------|
| PROPOSED GROUND |
| FLOOR PLAN |

| N | leters @ | 1:50@ | A3 |
|---|----------|-------|----|
| | | | |

2.5


3.5


2

0.5

0

1.5

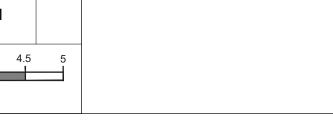

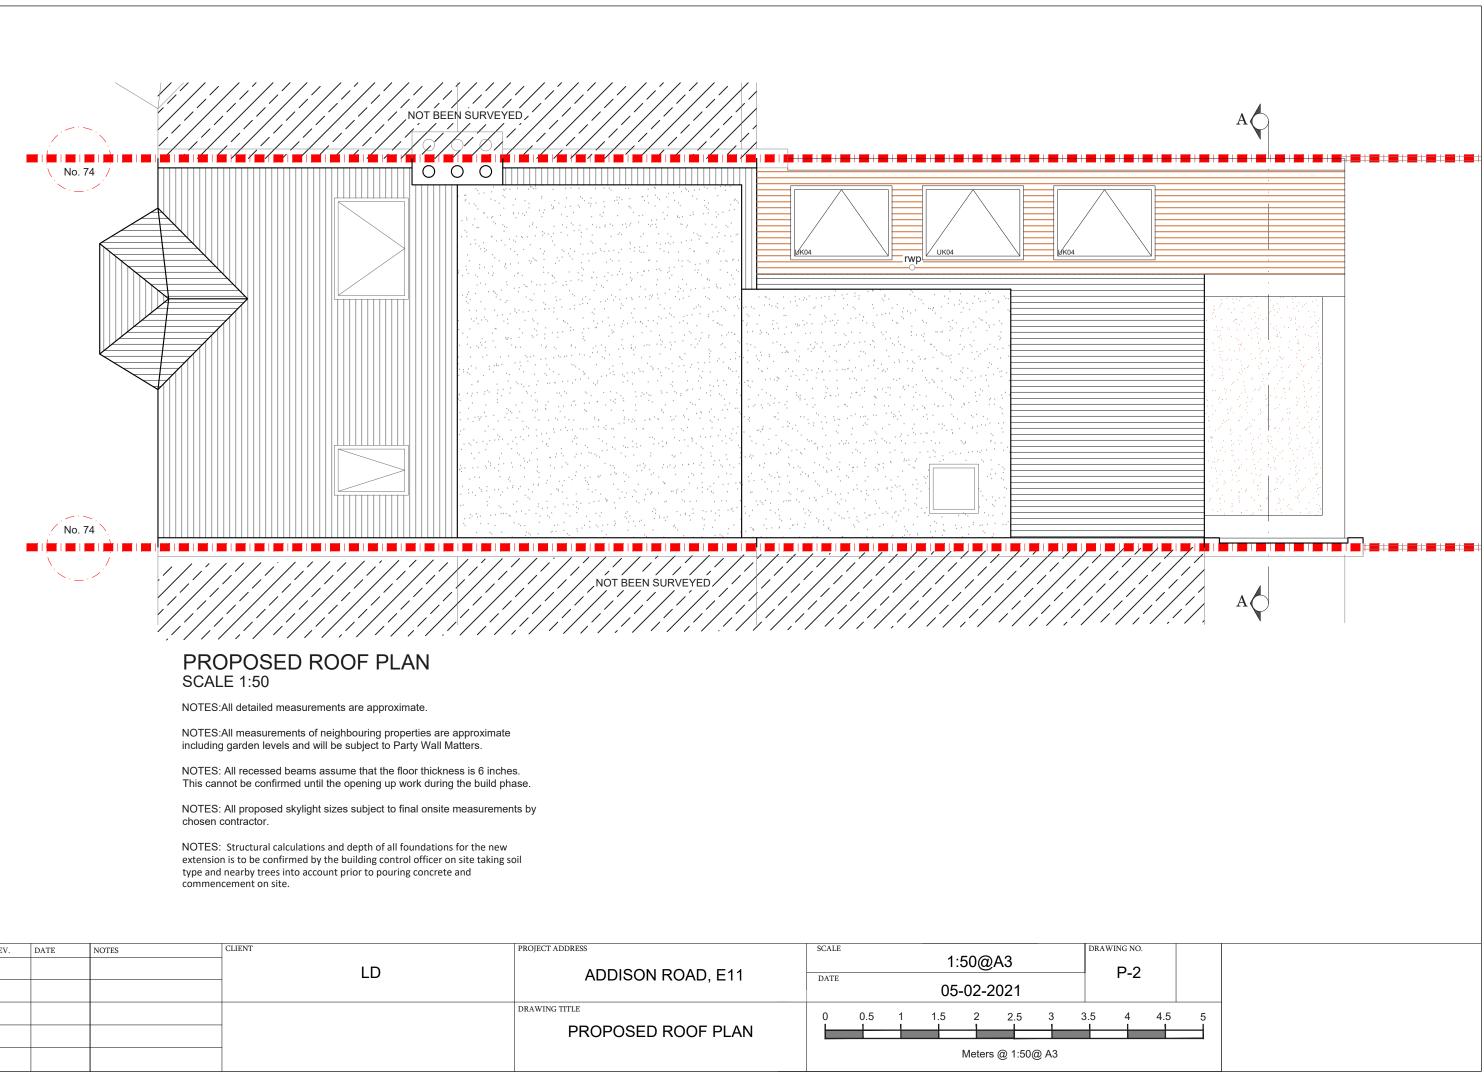

| REV. | DATE | NOTES | JENT PROJECT ADDRESS | | SCALE | | | 1. | 50@ | Δ3 | | DRAV | WING NO. |
|------|------|-------|----------------------|--------------------|-------|-----|---|-----|--------|----------|------|------|----------|
| | | | LD | ADDISON ROAD, E11 | DATE | | | | | | | _ | P-2 |
| | | | | | | | | 05 | -02-2 | 2021 | | | |
| | | | | DRAWING TITLE | 0 | 0.5 | 1 | 1.5 | 2 | 2.5 | 3 | 3.5 | 4 |
| | | | | PROPOSED ROOF PLAN | | | | | | | | | |
| | | | | | | | | | Meters | s @ 1:50 | @ A3 | | |

NOTES:All detailed measurements are approximate.

NOTES:All measurements of neighbouring properties are approximate including garden levels and will be subject to Party Wall Matters.

NOTES: All recessed beams assume that the floor thickness is 6 inches. This cannot be confirmed until the opening up work during the build phase.

measurements by chosen contractor.

depth of all foundations for the new extension is to be confirmed by the building control officer on site taking soil type and nearby trees into account prior to pouring concrete and commencement on site.

NOTES: All proposed skylight sizes subject to final onsite NOTES: Structural calculations and 1.1.1 . . . ·...

PROPOSED SIDE ELEVATION SCALE 1:50

| REV. | DATE | NOTES | CLIENT | PROJECT ADDRESS | SCALE | | | | | | | DRA | AWING N | 10. |
|------|------|-------|--------|-------------------------|----------------------|------|---|------------|--------|---------|------|-----|---------|-----|
| | | | - | D ADDISON ROAD, E11 | | | | 1: | 50@ | A3 | | | P- | 3 |
| | | | | | LD ADDISON ROAD, E11 | DATE | | 05-02-2021 | | | | | | Γ- |
| | | | | DRAWING TITLE | 0 | 0.5 | 1 | 1.5 | 2 | 2.5 | 3 | 3.5 | 4 | |
| | | | - | PROPOSED SIDE ELEVATION | | | | | | | | | | |
| | | | | | | | | | Meters | @ 1:50(| @ A3 | | | |

