




EXISTING GROUND FLOOR PLAN

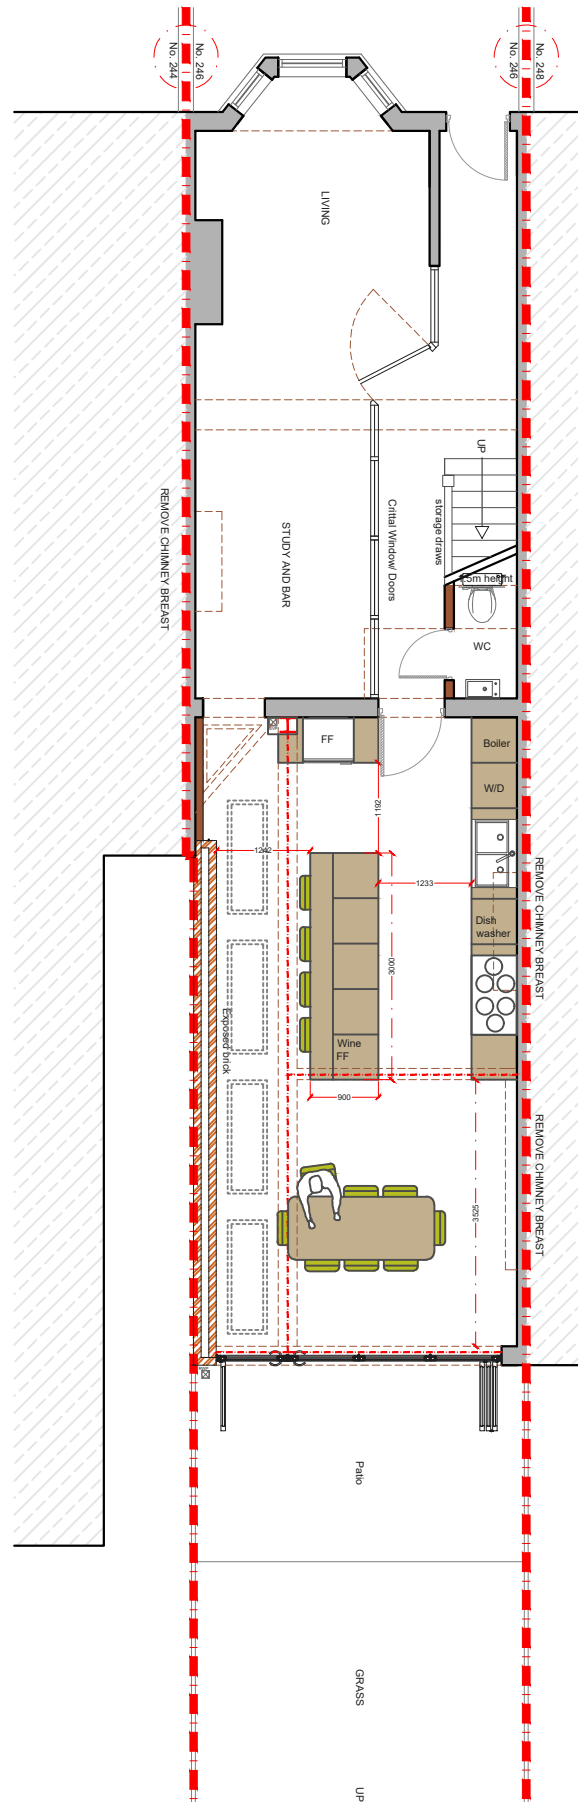


EXISTING FIRST FLOOR PLAN

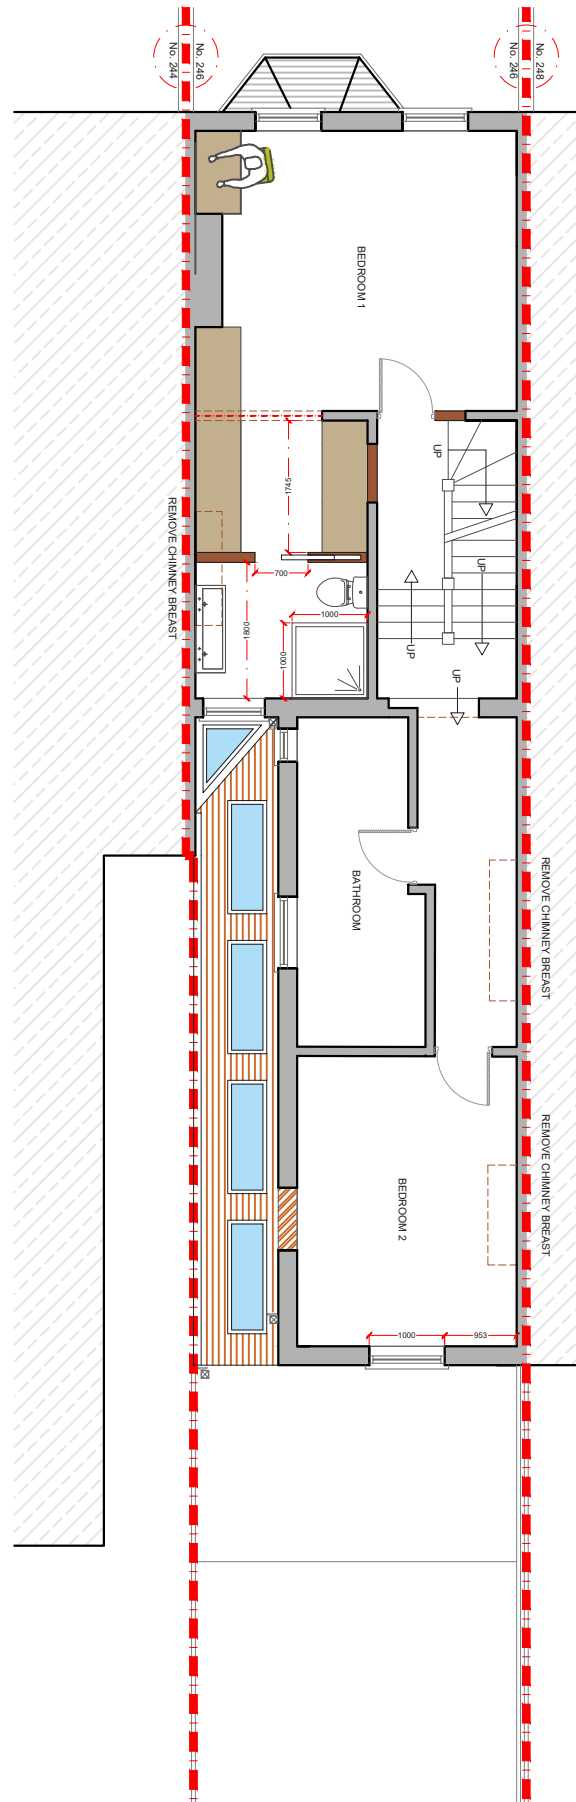


EXISTING ROOF FLOOR PLAN

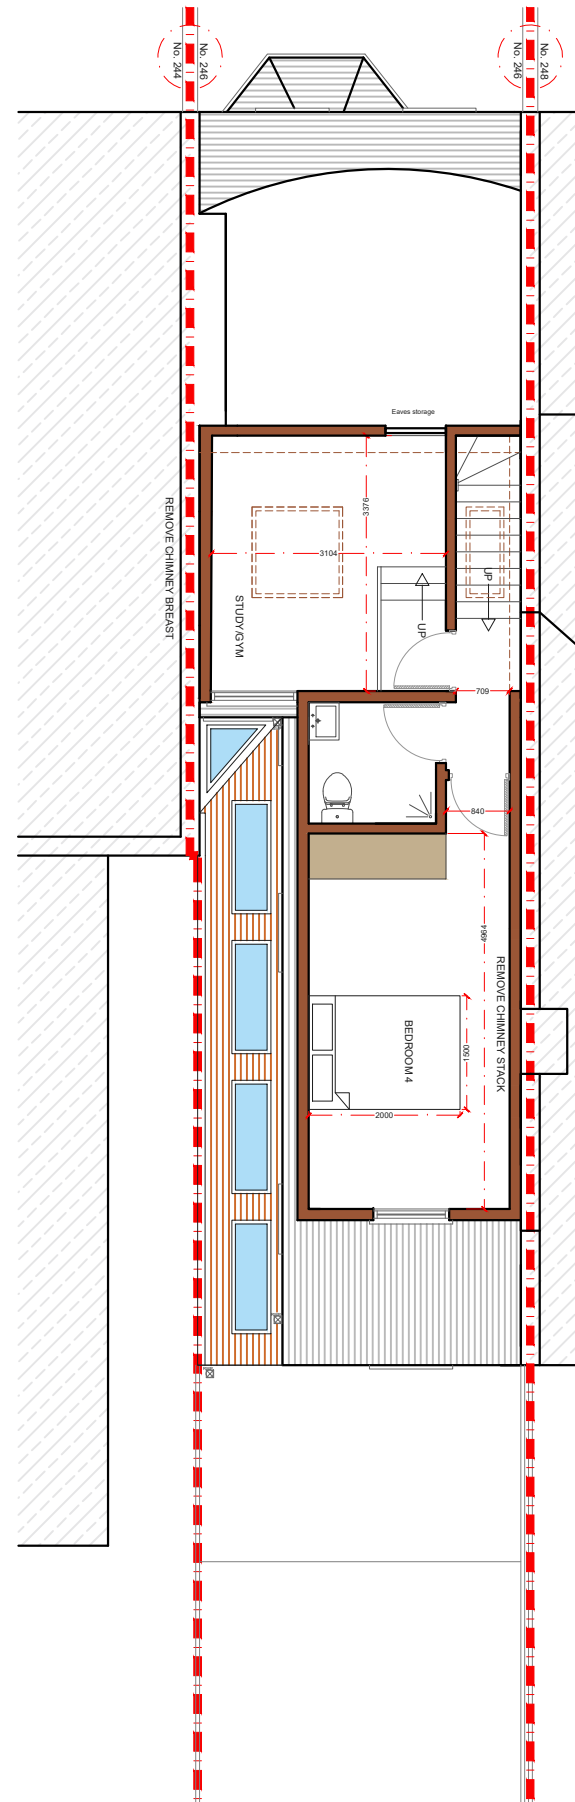

EXISTING ROOF FLOOR PLAN

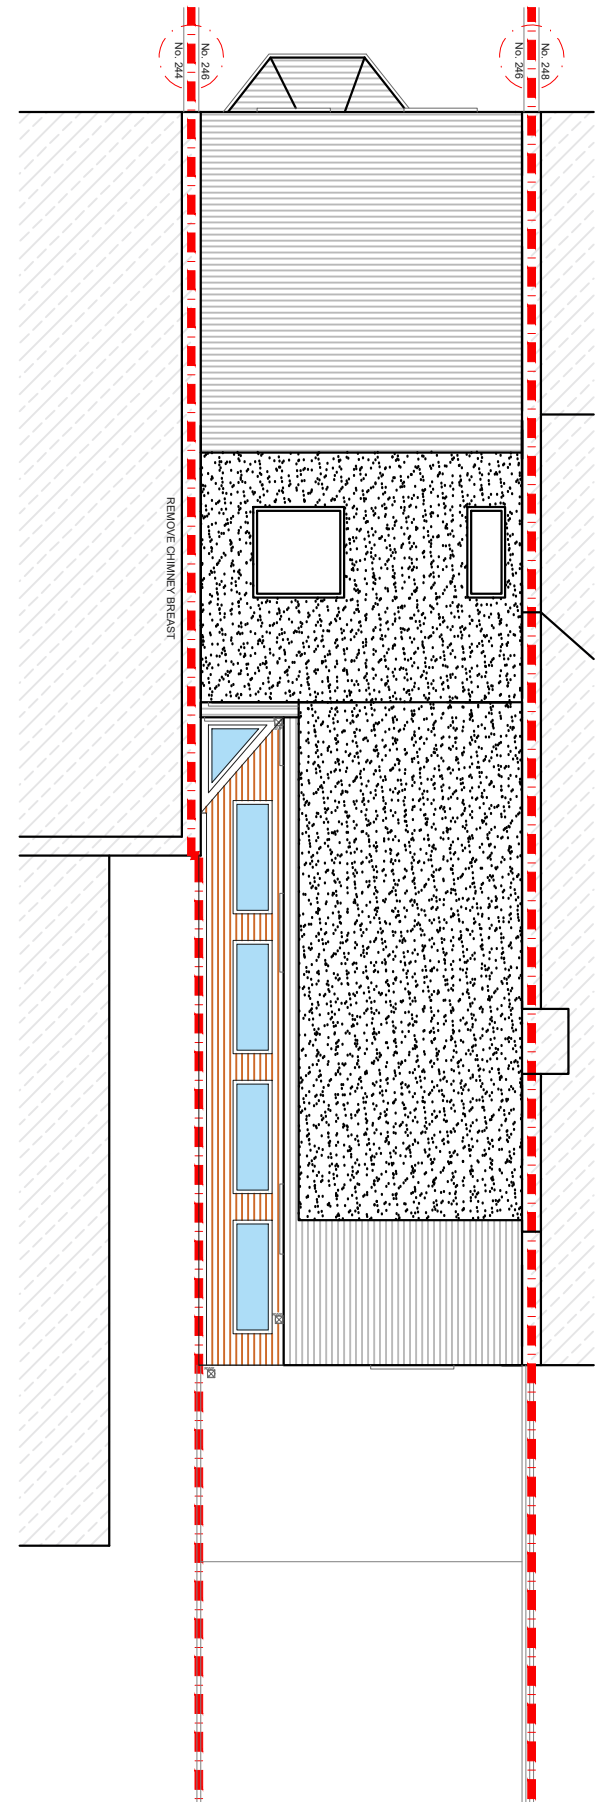


REV.	DATE	NOTES	CLIENT EH	PROJECT ADDRESS Underhill Road, SE22	SCALE 1:100@A3		DRAWING NO. P- 01	
					DATE 14-07-2021			
				DRAWING TITLE Proposed Plans	<div>012345678910</div> <div><div></div></div> <div>Meters @ 1:100@ A3</div>			

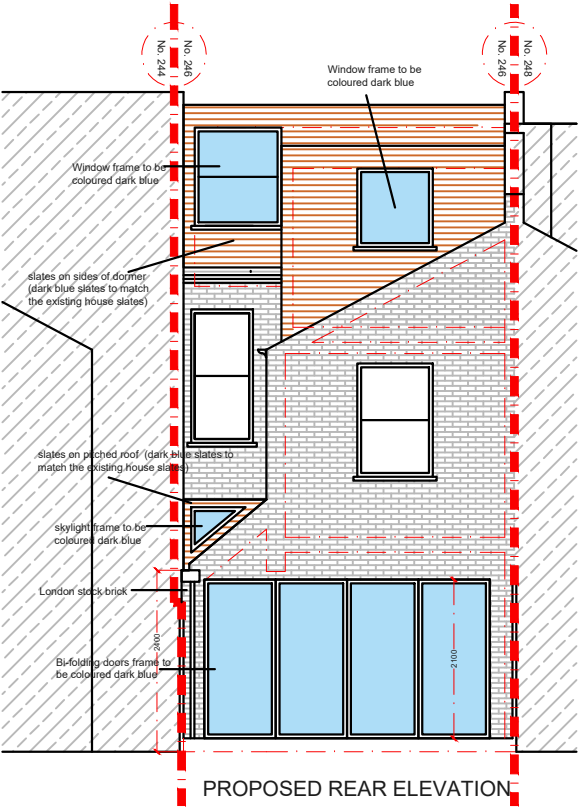

PROPOSED REAR ELEVATION



PROPOSED FRONT ELEVATION

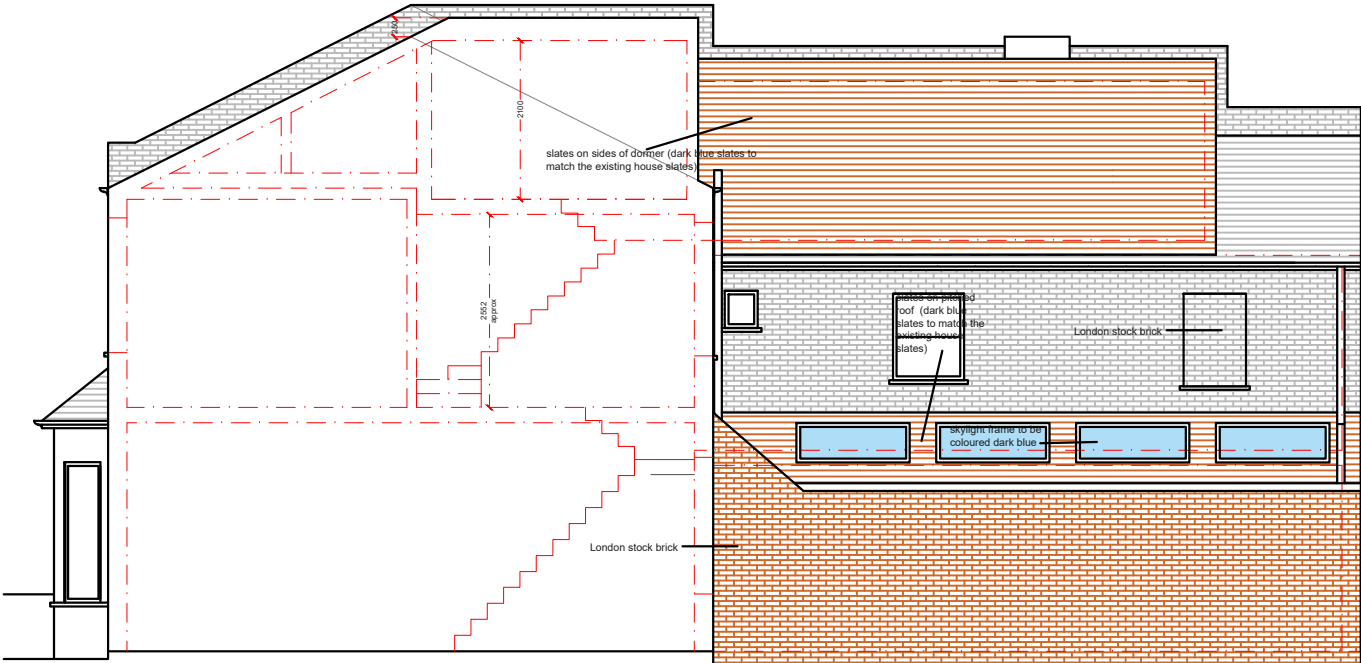

PROPOSED SIDE ELEVATION


NOTES: All detailed measurements are approximate.


NOTES: All measurements of neighbouring properties are approximate including garden levels and will be subject to Party Wall Matters.


NOTES: All recessed beams assume that the floor thickness is 6 inches. This cannot be confirmed until the opening up work during the build phase.

NOTES: All proposed skylight sizes subject to final onsite measurements by chosen contractor.

NOTES: Structural calculations and depth of all foundations for the new extension is to be confirmed by the building control officer on site taking soil type and nearby trees into account prior to pouring concrete and commencement on site.

REV.	DATE	NOTES	CLIENT EH	PROJECT ADDRESS Underhill Road, SE22	SCALE 1:100@A3	DRAWING NO. P- 02		
					DATE 14-07-2021			
				DRAWING TITLE Proposed Elevations	0 1 2 3 4 5 6 7 8 9 10 			
					Meters @ 1:100@ A3			

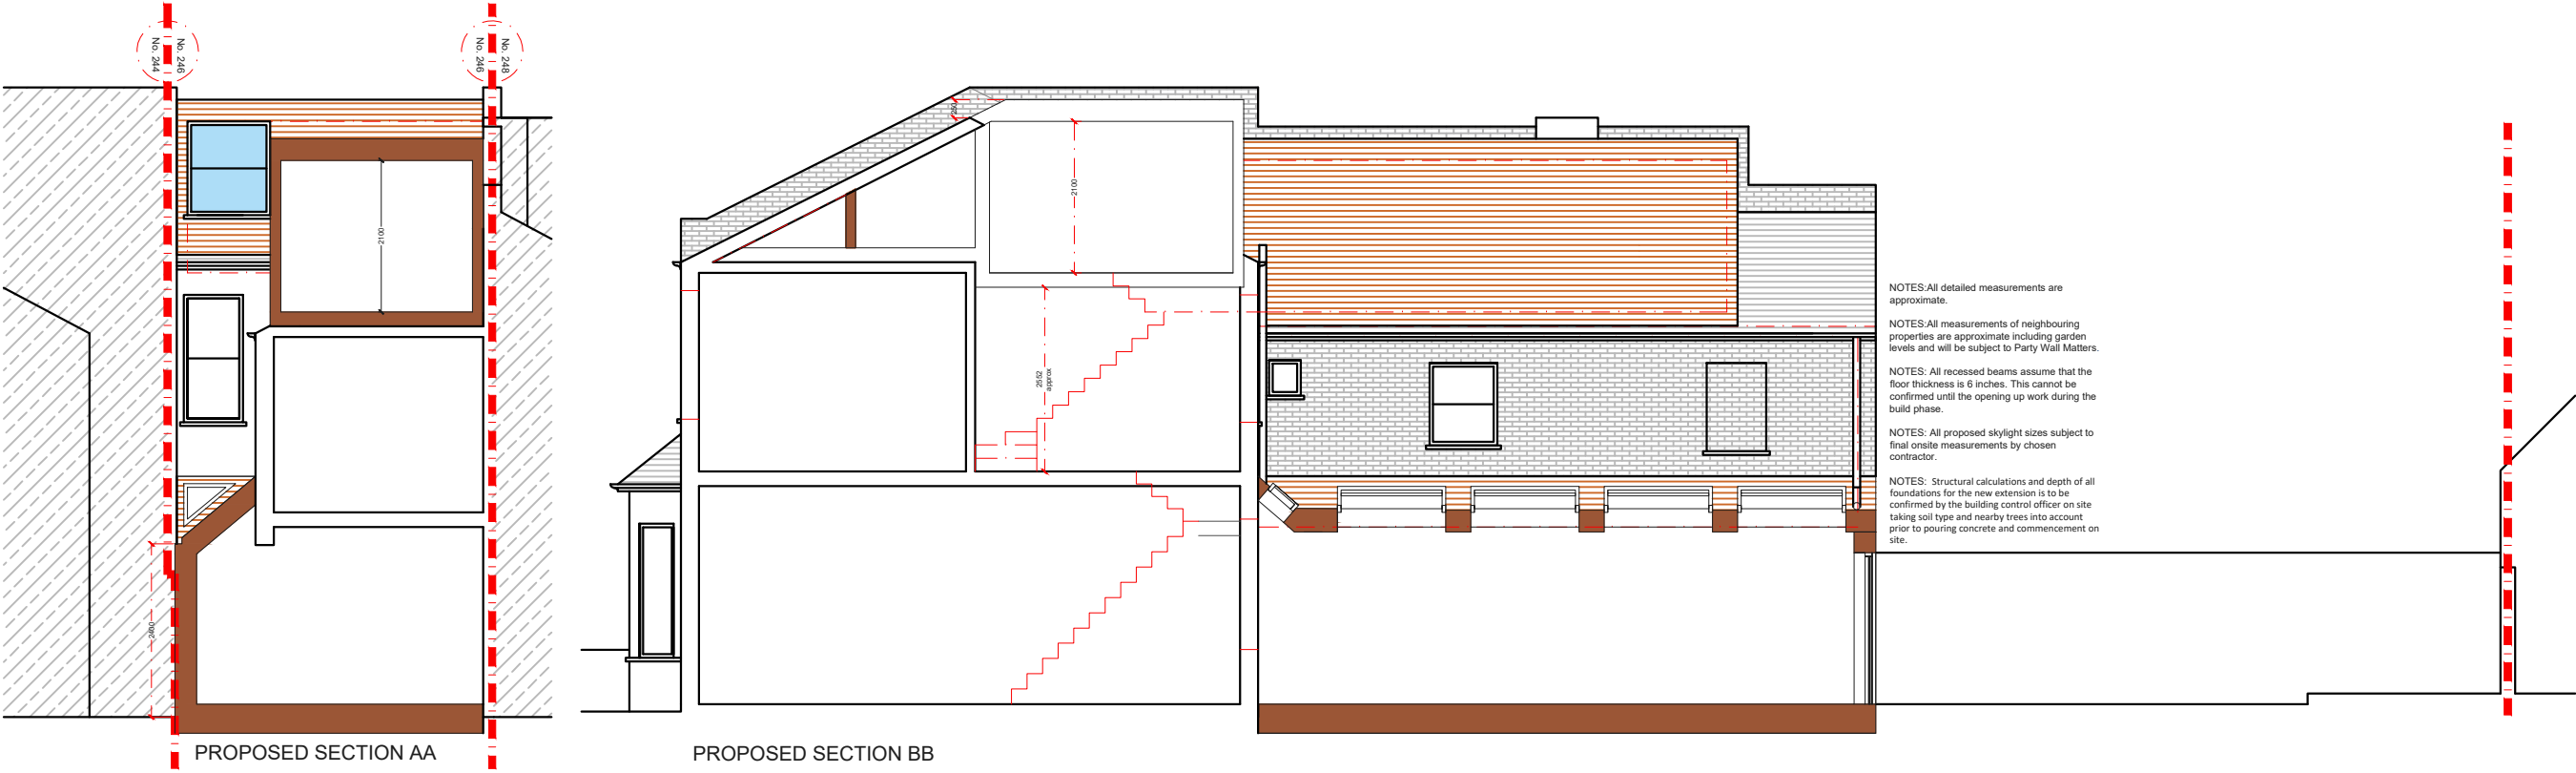

REV.	DATE	NOTES	CLIENT EH	PROJECT ADDRESS Underhill Road, SE22	SCALE 1:100@A3	DRAWING NO. P- 03	
					DATE 03-08-2021		
				DRAWING TITLE Proposed section AA and BB	0 1 2 3 4 5 6 7 8 9 10 		
					Meters @ 1:100@ A3		