


PROPOSED GROUND FLOOR PLAN

SCALE 1:50

- NOTES: All detailed measurements are approximate.
- NOTES: All measurements of neighbouring properties are approximate including garden levels and will be subject to Party Wall Matters.
- NOTES: All recessed beams assume that the floor thickness is 6 inches. This cannot be confirmed until the opening up work during the build phase.
- NOTES: All proposed skylight sizes subject to final onsite measurements by chosen contractor.
- NOTES: Structural calculations and depth of all foundations for the new extension is to be confirmed by the building control officer on site taking soil type and nearby trees into account prior to pouring concrete and commencement on site.

REV.	DATE	NOTES	CLIENT	PROJECT ADDRESS	SCALE	DRAWING NO.
			HLP	ELM PARK, SW2	1:50@A3	P- 1
					DATE	
					11-01-2021	
				DRAWING TITLE	<p>Meters @ 1:50@ A3</p>	
				PROPOSED GROUND FLOOR PLAN		

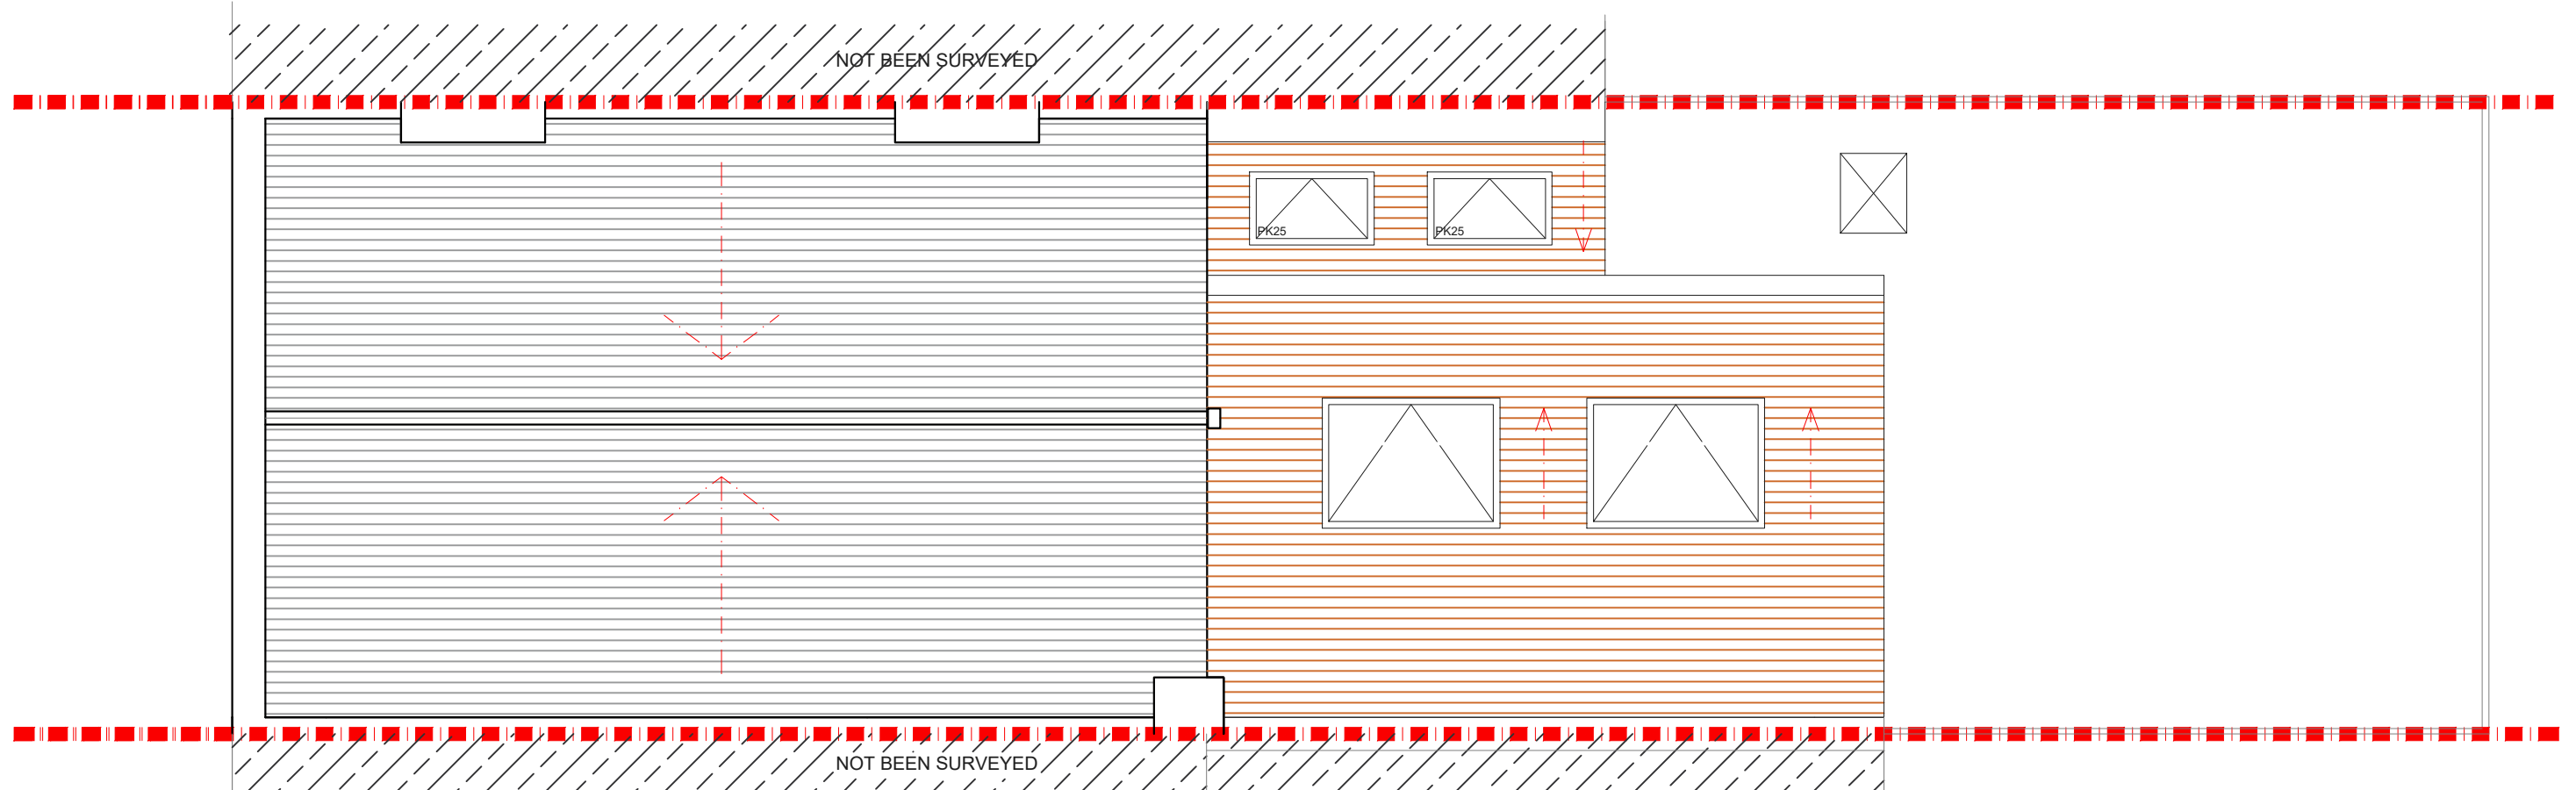

PROPOSED ROOF PLAN
SCALE 1:50

NOTES: All detailed measurements are approximate.

NOTES: All measurements of neighbouring properties are approximate including garden levels and will be subject to Party Wall Matters.


NOTES: All recessed beams assume that the floor thickness is 6 inches. This cannot be confirmed until the opening up work during the build phase.

NOTES: All proposed skylight sizes subject to final onsite measurements by chosen contractor.

NOTES: Structural calculations and depth of all foundations for the new extension is to be confirmed by the building control officer on site taking soil type and nearby trees into account prior to pouring concrete and commencement on site.

Approximate location for an approved extension REF 20/01403/FUL

REV.	DATE	NOTES	CLIENT	PROJECT ADDRESS	SCALE	DRAWING NO.
			HLP	ELM PARK, SW2	1:50@A3	P- 2
					DATE	
					11-01-2021	
				DRAWING TITLE	<p>Meters @ 1:50@ A3</p>	
				PROPOSED ROOF PLAN		

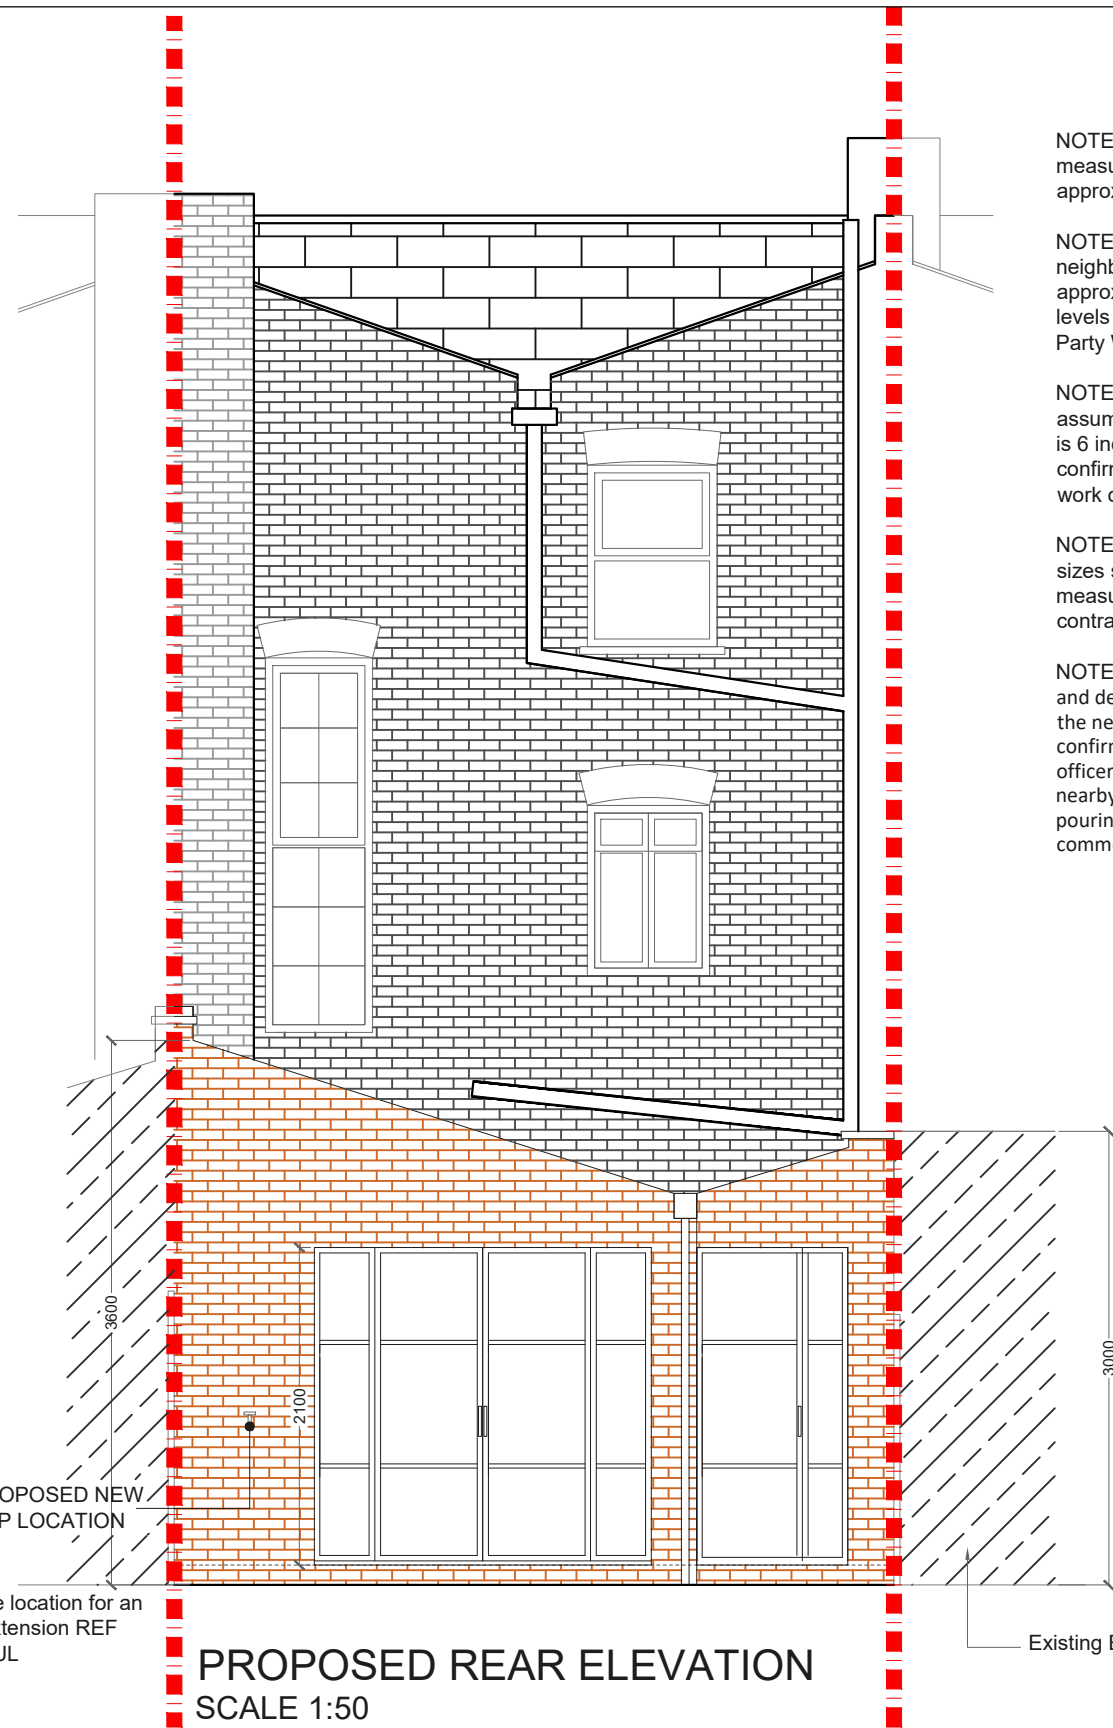

PROPOSED REAR ELEVATION
SCALE 1:50


NOTES: All detailed measurements are approximate.

NOTES: All measurements of neighbouring properties are approximate including garden levels and will be subject to Party Wall Matters.

NOTES: All recessed beams assume that the floor thickness is 6 inches. This cannot be confirmed until the opening up work during the build phase.

NOTES: All proposed skylight sizes subject to final onsite measurements by chosen contractor.

NOTES: Structural calculations and depth of all foundations for the new extension is to be confirmed by the building control officer on site taking soil type and nearby trees into account prior to pouring concrete and commencement on site.

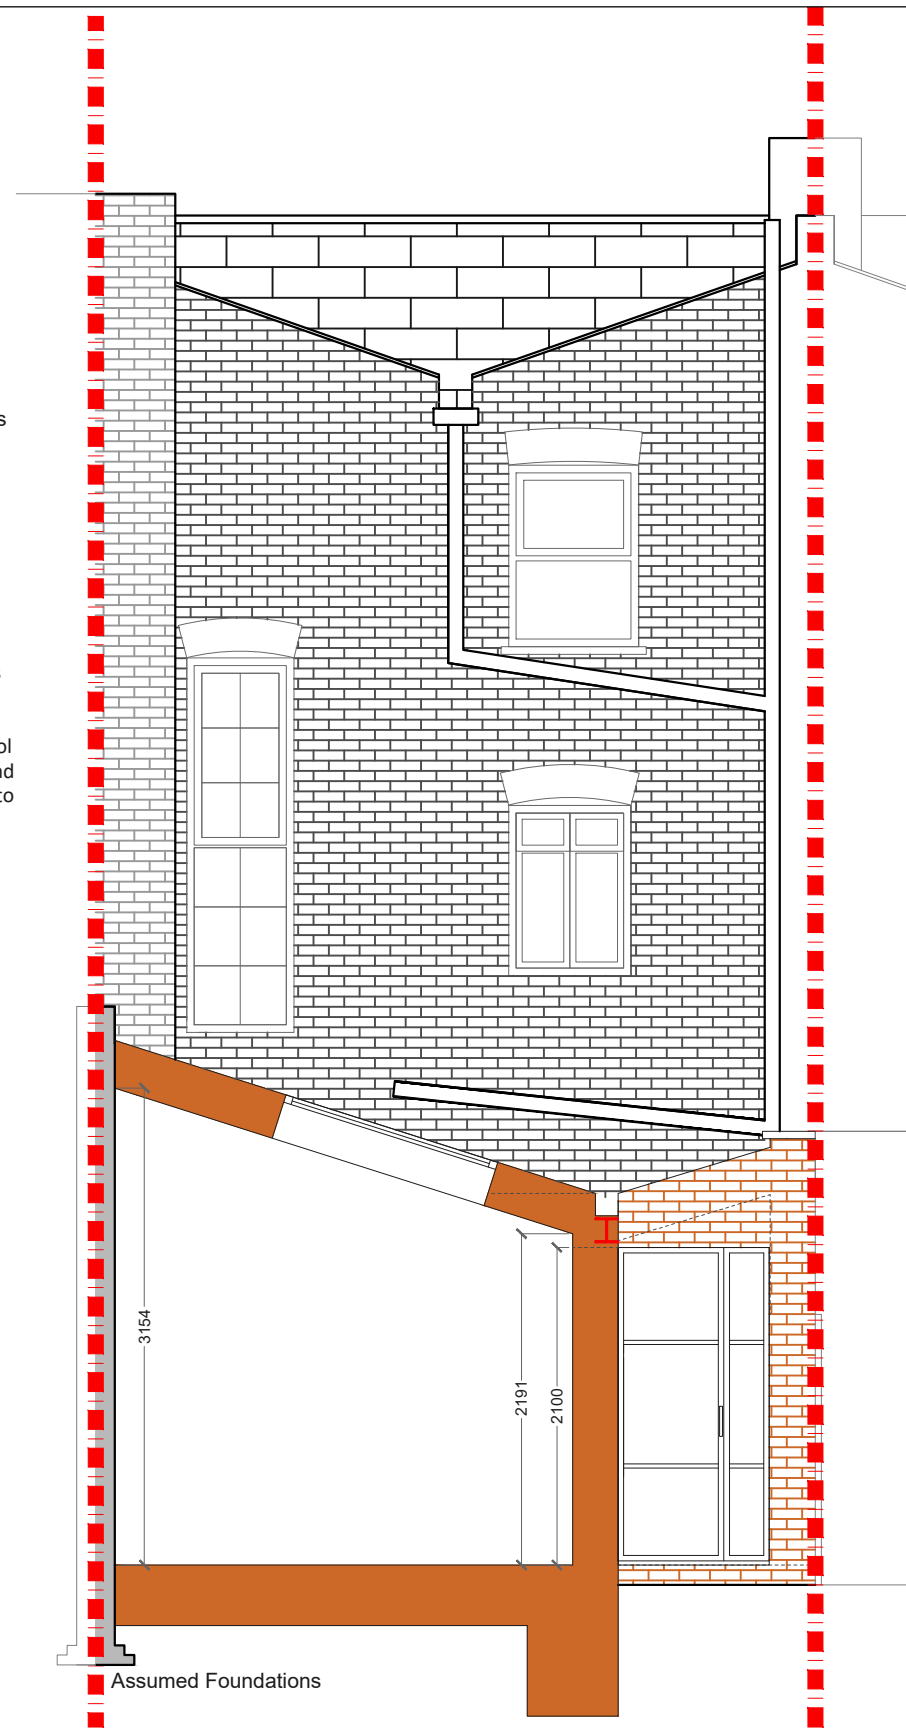

PROPOSED SECTION AA
SCALE 1:50

REV.	DATE	NOTES	CLIENT	PROJECT ADDRESS	SCALE	DRAWING NO.
			HLP	ELM PARK, SW2	1:50@A3	P- 3
					DATE	
					11-01-2021	
				DRAWING TITLE	0 0.5 1 1.5 2 2.5 3 3.5 4 4.5 5	
				PROPOSED REAR ELEVATION & SECTION AA	Meters @ 1:50@ A3	