


CLIENT			PROJECT		SCALE		DRAWING NO.		REV.		
G & L M			DALLINGER ROAD SE12		1:50@A3		P - 1				
			DRAWING TITLE		DATE		DRAWN				
			PROPOSED GROUND FLOOR PLAN		14-05-18		MG				
REV			DATE			NOTES			<p>Meters @ 1:50@ A3</p>		
									<p>342 Clapham Road London SW9 9AJ Tel: 0207 242 5353 hello@designteam.co.uk www.designteam.co.uk</p>		

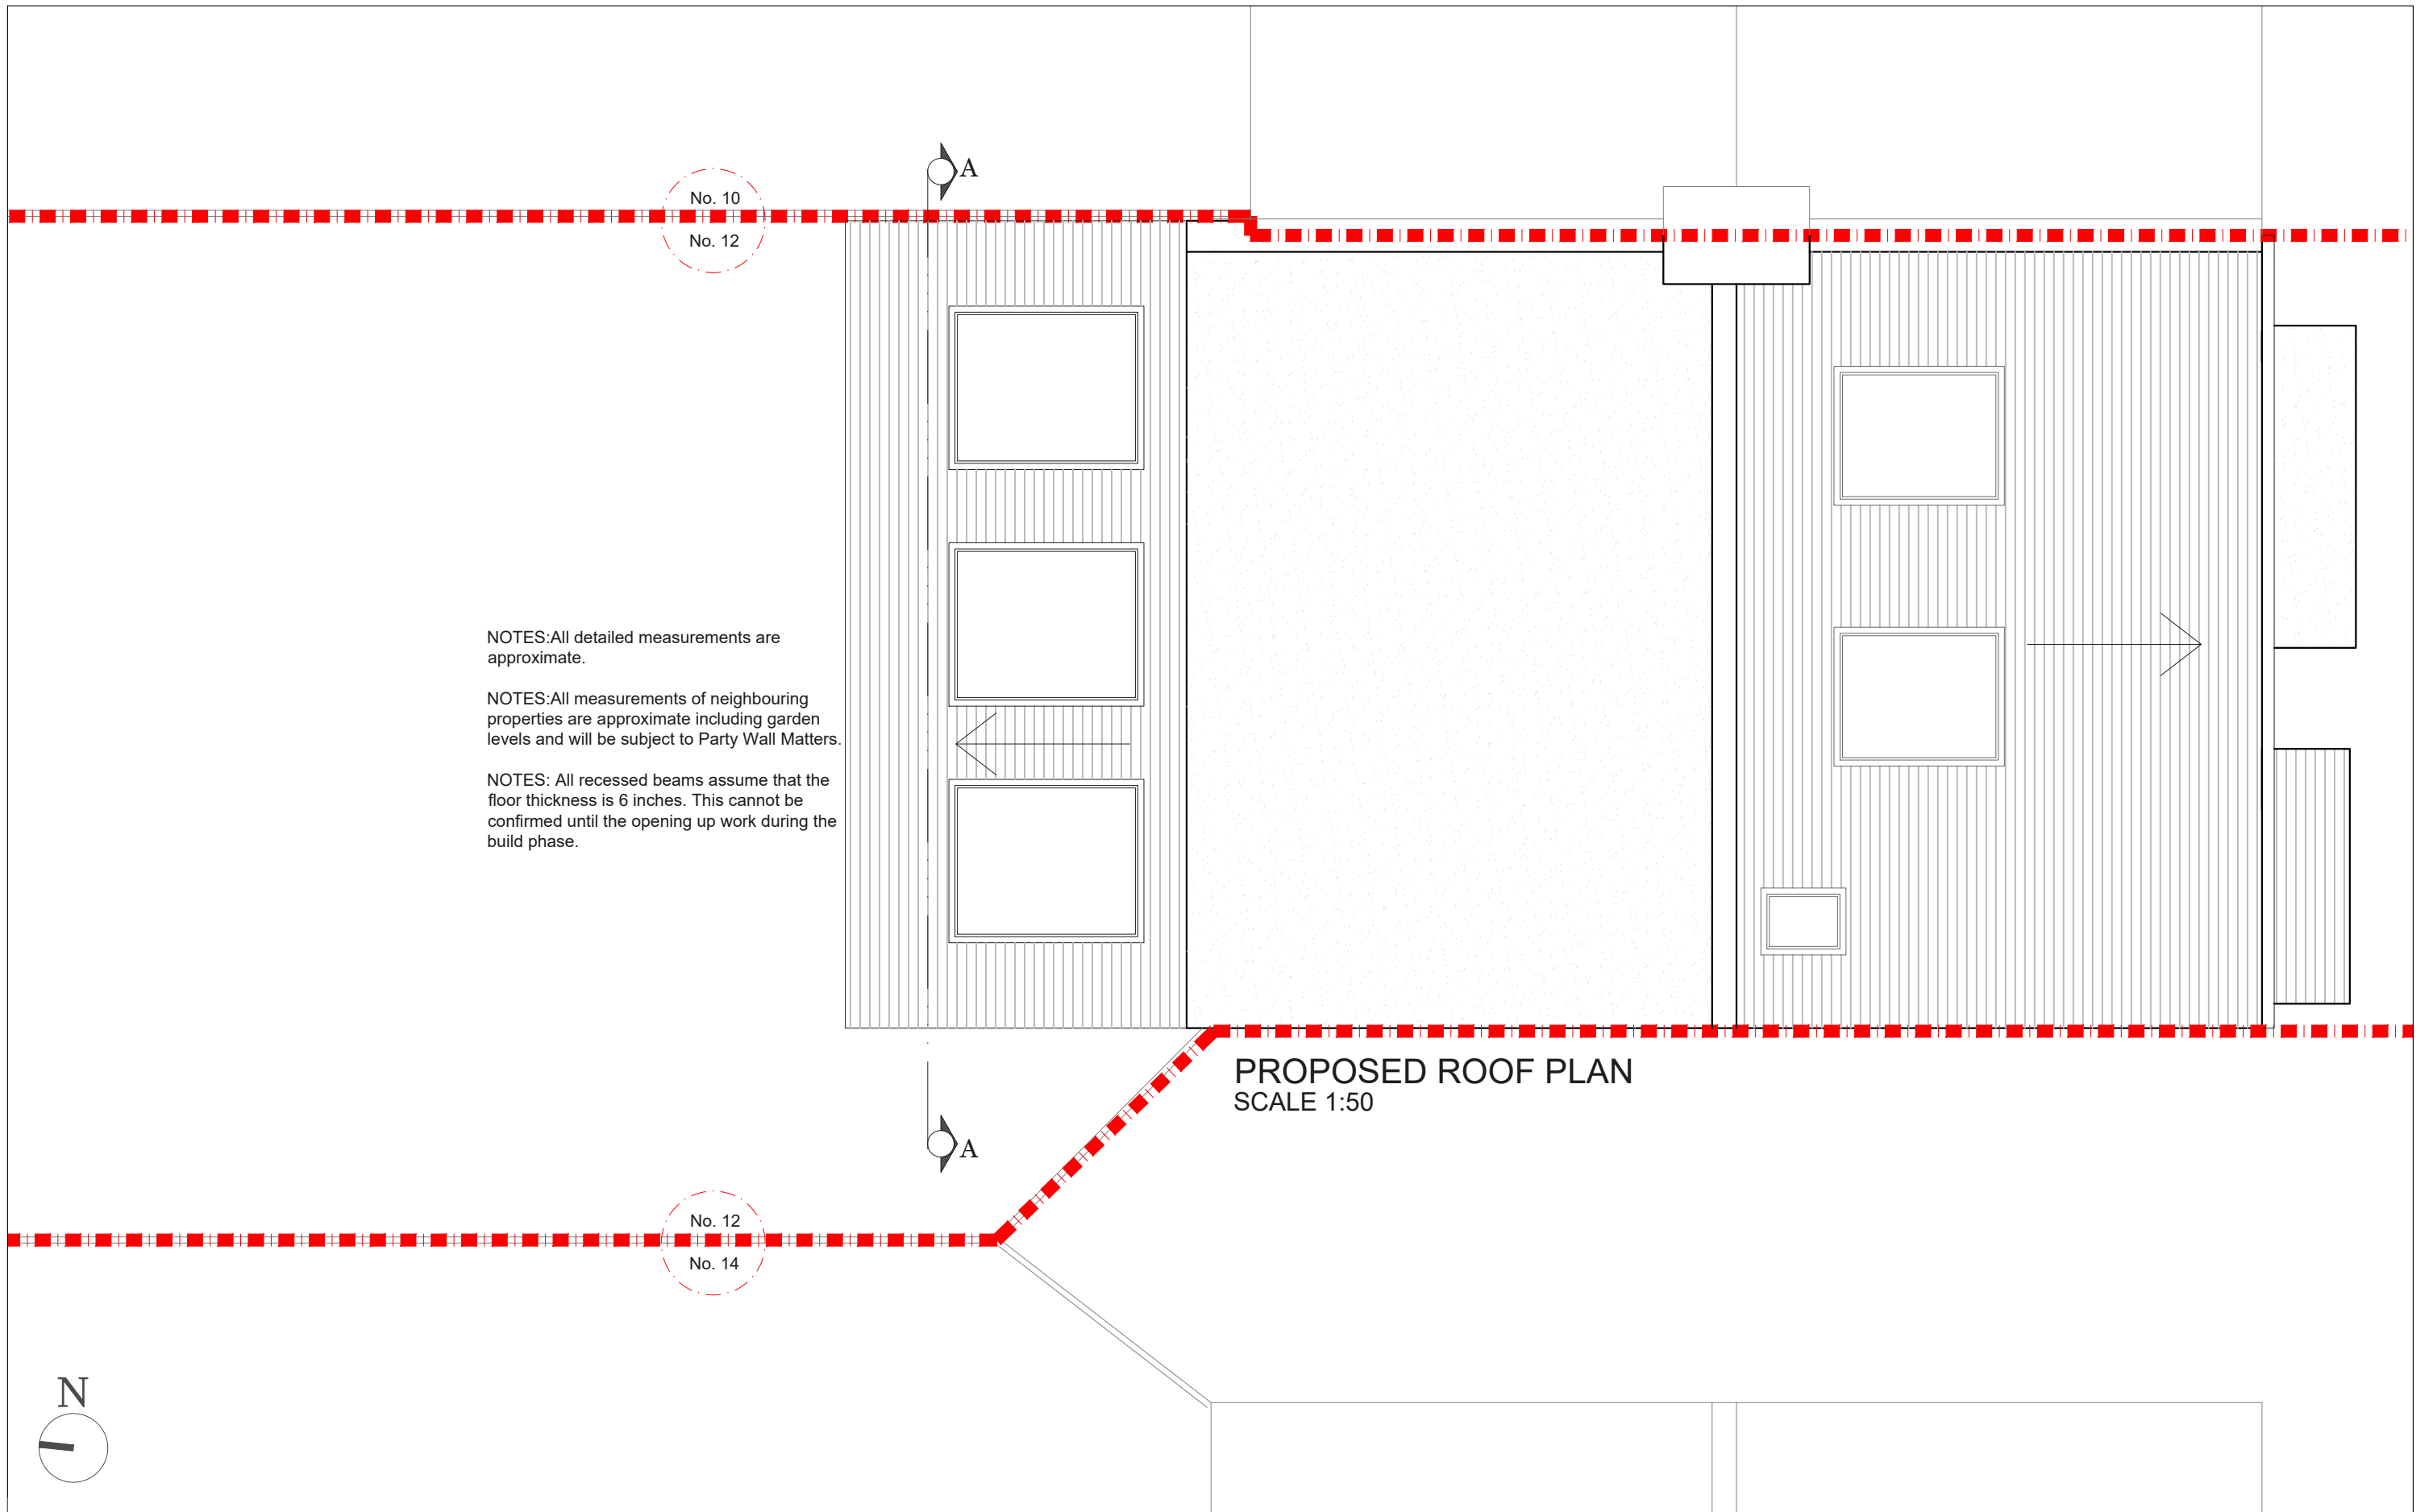


NOTES: All detailed measurements are approximate.

NOTES: All measurements of neighbouring properties are approximate including garden levels and will be subject to Party Wall Matters.

NOTES: All recessed beams assume that the floor thickness is 6 inches. This cannot be confirmed until the opening up work during the build phase.

**PROPOSED ROOF PLAN**  
SCALE 1:50

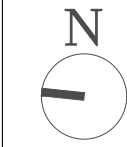


			CLIENT	<b>G &amp; L M</b>		PROJECT	<b>DALLINGER ROAD SE12</b>		SCALE	<b>1:50@A3</b>		DRAWING NO.	REV.	
									DATE	<b>08-03-18</b>		DRAWN	<b>MG</b>	
												<b>P - 2</b>		
REV	DATE	NOTES				DRAWING TITLE	<b>PROPOSED ROOF PLAN</b>			<p>Meters @ 1:50@ A3</p>				
												342 Clapham Road London SW9 9AJ Tel: 0207 242 5353 hello@designteam.co.uk www.designteam.co.uk		


NOTES: All detailed measurements are approximate.

NOTES: All measurements of neighbouring properties are approximate including garden levels and will be subject to Party Wall Matters.

NOTES: All recessed beams assume that the floor thickness is 6 inches. This cannot be confirmed until the opening up work during the build phase.

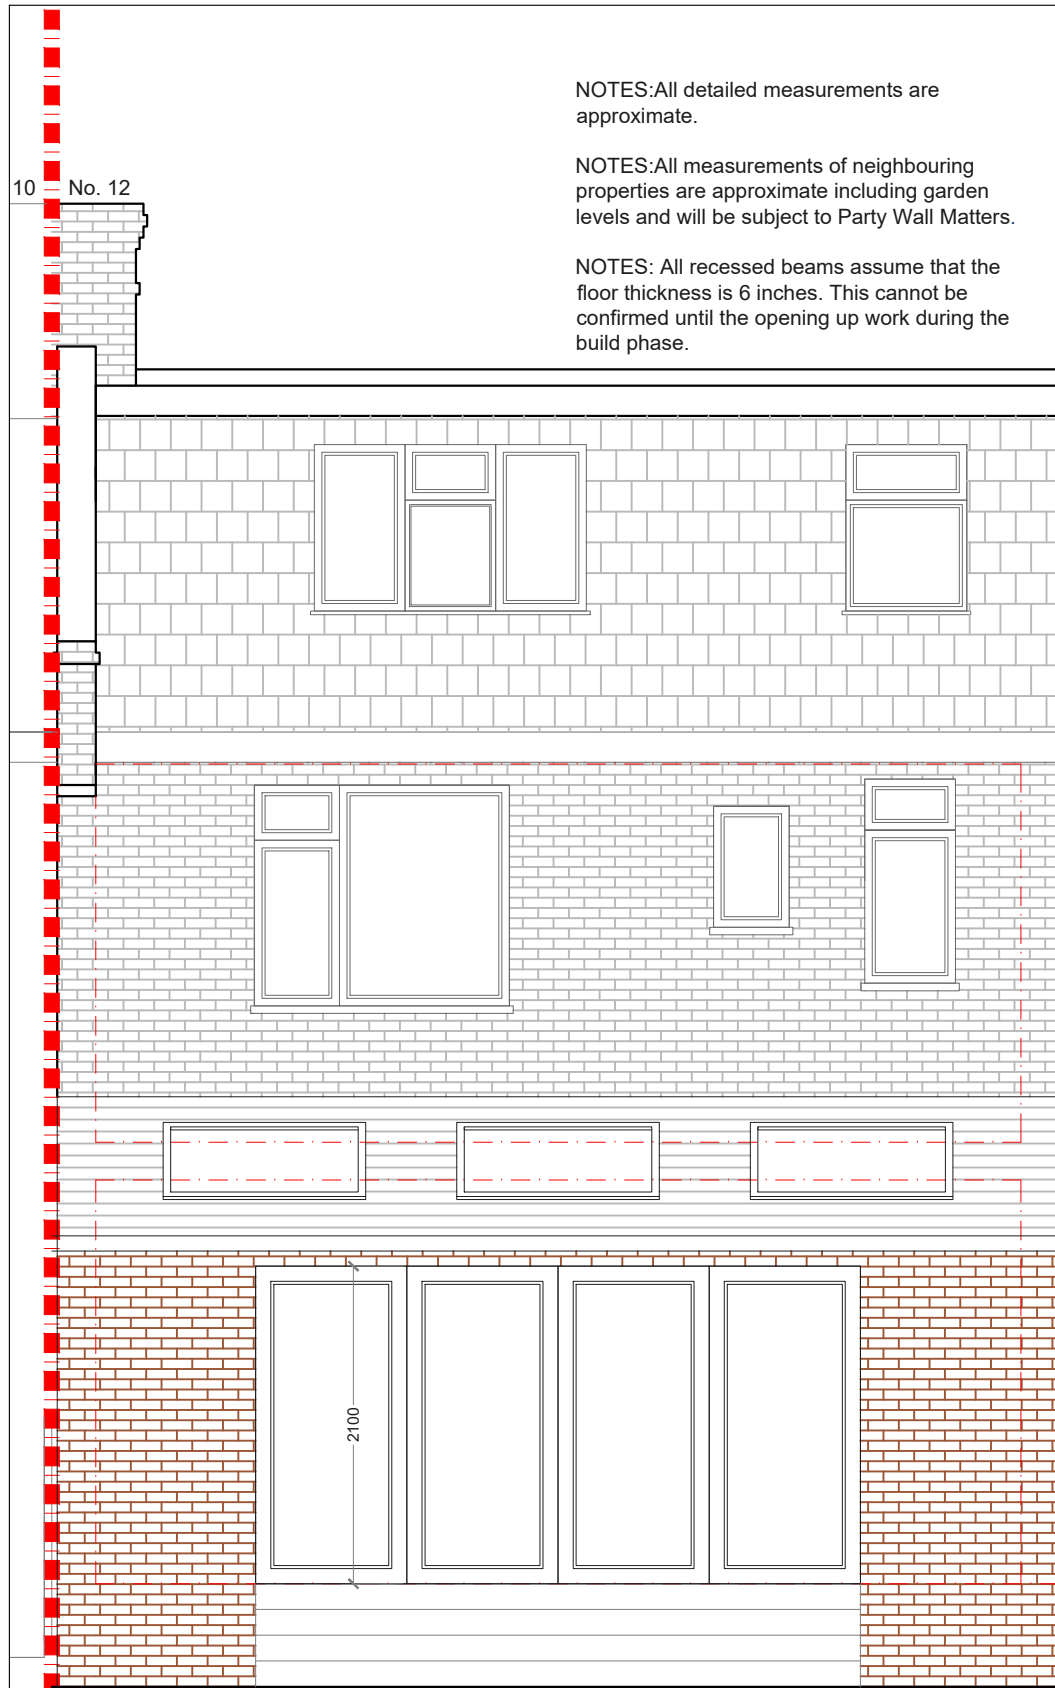

**PROPOSED REAR ELEVATION**  
SCALE 1:50

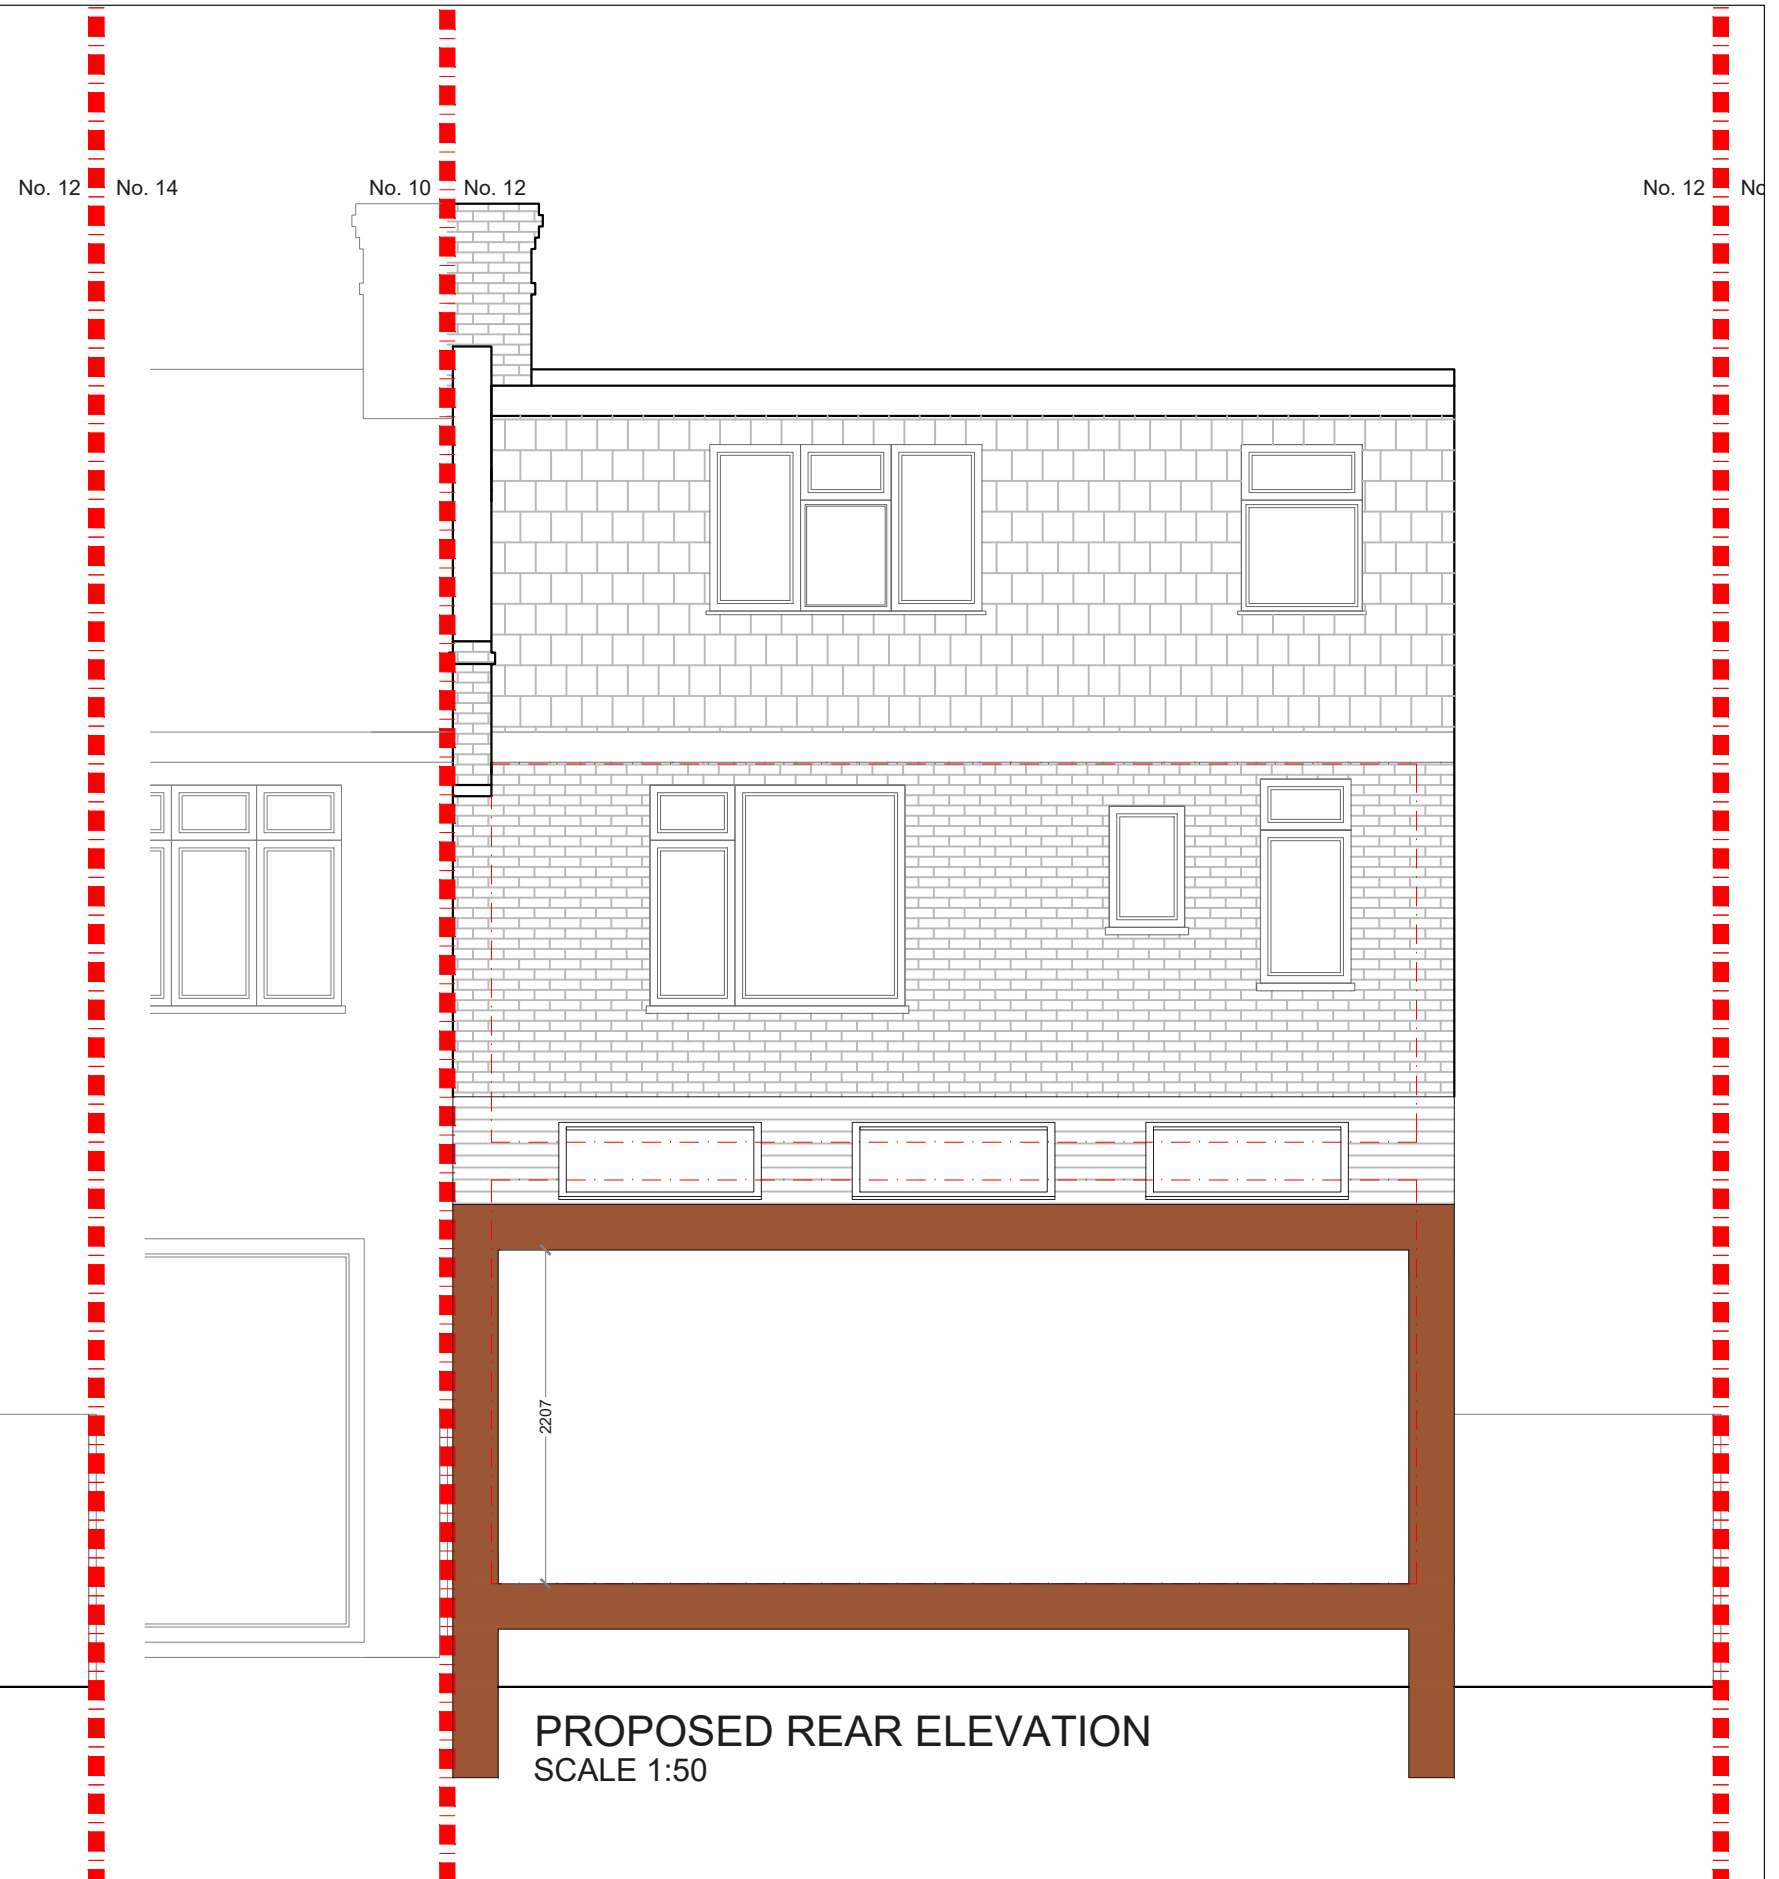

**PROPOSED REAR ELEVATION**  
SCALE 1:50

			CLIENT	<b>G &amp; L M</b>		PROJECT	<b>DALLINGER ROAD SE12</b>		SCALE	<b>1:50@A3</b>	DRAWING NO.	REV.	
								DATE	<b>14-05-18</b>	DRAWN	<b>MG</b>	<b>P - 3</b>	
						DRAWING TITLE	<b>PROPOSED REAR ELEVATION AND SECTION</b>		<p>Meters @ 1:50@ A3</p>				
REV	DATE	NOTES											

**designteam**  
 342 Clapham Road London SW9 9AJ  
 Tel: 0207 242 5353  
 hello@designteam.co.uk  
 www.designteam.co.uk